


WINDOW SCHEDULE


WINDOW #	# UNITS	WINDOW RO.	HEADER HEIGHT	HEADER	JACK STUDS	NOTES
UNIT "K" WINDOWS						
K101	1	9'-1 1/2" W x 8'-0" H	8'-0"	(3) P4" x 11 1/8" LVL	2	SEE PORTAL FRAME DETAIL, SHEET AB
K102	1	3'-4" W x 8'-0" H	8'-0"	(2) 2x10	1	
K103	1	3'-0 1/2" W x 8'-0" H	8'-0"	(2) P4" x 11 1/8" LVL	2	
K201	3	(3) # 3'-0 1/2" x 5'-10 1/2"	8'-0"	(3) P4" x 9 1/2" LVL	2	DRYWALL RETURNS TO WINDOW
K202	1	3'-0 1/2" x 5'-10 1/2"	8'-0"	(3) P4" x 9 1/2" LVL	2	DRYWALL RETURNS TO WINDOW
K203	1	3'-0 1/2" x 4'-5 1/2"	8'-0"	(2) P4" x 9 1/2" LVL	2	DRYWALL RETURNS TO WINDOW
K204	1	2'-4 1/2" x 4'-5 1/2"	8'-0"	(2) 2x10	2	DRYWALL RETURNS TO WINDOW
K205	1	3'-0 1/2" x 5'-10 1/2"	8'-0"	(2) 2x10	2	DRYWALL RETURNS TO WINDOW
K301	2	(2) # 3'-0 1/2" x 4'-5 1/2"	1'-10 1/2"	(2) P4" x 9 1/2" LVL	2	DRYWALL RETURNS TO WINDOW
K302	1	2'-0 1/2" x 4'-5 1/2"	1'-10 1/2"	(2) P4" x 9 1/2" LVL	2	DRYWALL RETURNS TO WINDOW
K303	1	3'-0 1/2" x 4'-5 1/2"	1'-10 1/2"	(2) 2x10	1	DRYWALL RETURNS TO WINDOW
K304	2	(2) # 3'-0 1/2" x 4'-5 1/2"	1'-10 1/2"	(2) 2x10	2	DRYWALL RETURNS TO WINDOW
K401	1	2'-0 1/2" W x 2'-0 1/2" H	1'-5 1/2"	(2) 2x10	2	DRYWALL RETURNS TO WINDOW
K402	1	3'-2 1/2" x 6'-10 1/2"	1'-5 1/2"	(2) 2x10	2	DRYWALL RETURNS TO WINDOW

NOTE: WINDOW RO. ARE BASED ON ANDERSEN WINDOW SIZES

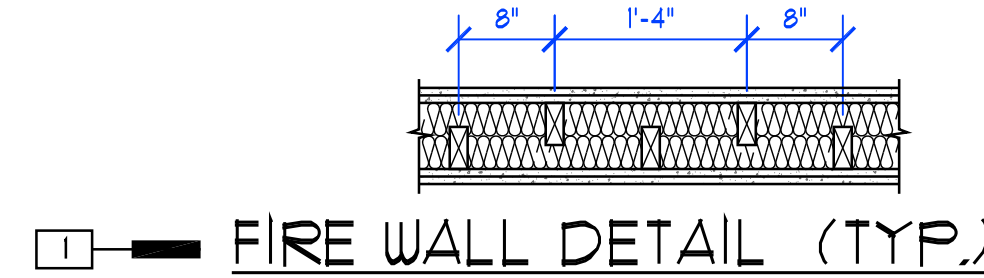


FIRE WALL DETAIL (TYP.)


SCALE 1/2" = 1'-0" (DESIGN NO. GA-UP 3910, TEST NO. NGC 2311, STC RATING 51)
 BASE LAYER: 1/2" (12.5MM) TOUGHROCK FIREGUARD X OR 1/2" DENSARMOR PLUS FIREGUARD GYPSUM BOARD APPLIED HORIZONTALLY TO EACH SIDE OF 2x4 WOOD STUDS @ 16" O.C. STAGGERED 8" O.C. ON 2x6 WOOD PLATES WITH 1-3/4" (48MM) 8D COATED NAILS 24" O.C. FACE LAYER: 1/2" (12.5MM) TOUGHROCK FIREGUARD X OR 1/2" DENSARMOR PLUS FIREGUARD GYPSUM BOARD APPLIED HORIZONTALLY TO STUDS WITH 2-3/4" (60MM) 8D COATED NAILS 8" O.C. STAGGER VERTICAL JOINTS 16" O.C. EACH LAYER AND SIDE. HORIZONTAL BRACING REQUIRED AT MID HEIGHT. SOUND TESTED WITH NAILS FOR BASE LAYER SPACED 6" O.C.

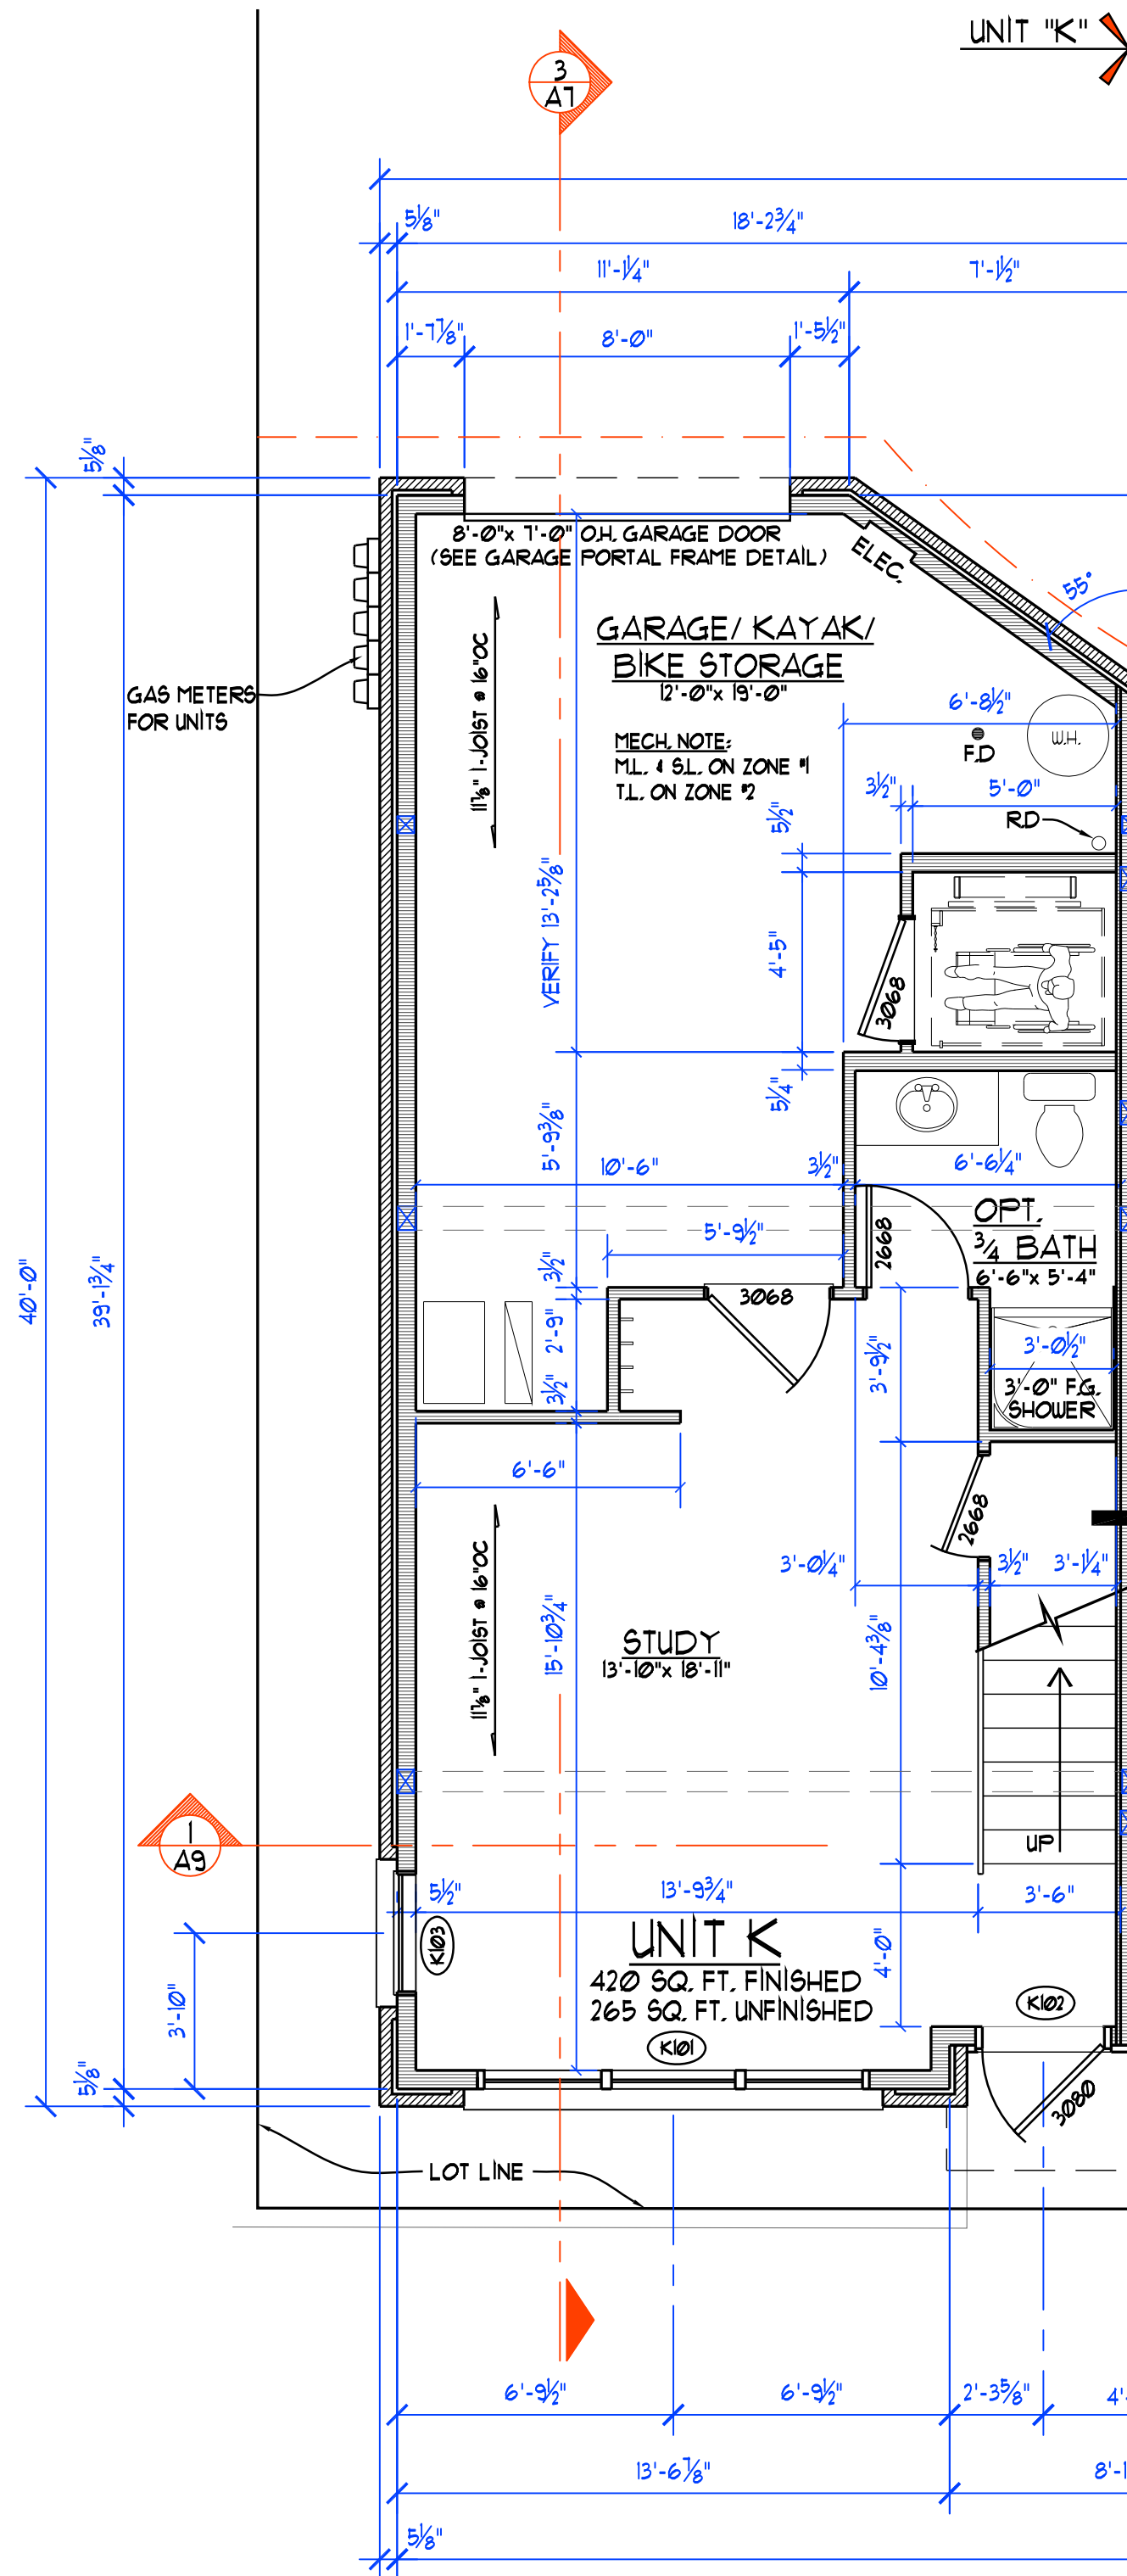


MAIN LEVEL FLOOR PLAN
 SCALE 1/4" = 1'-0"
 NORTH

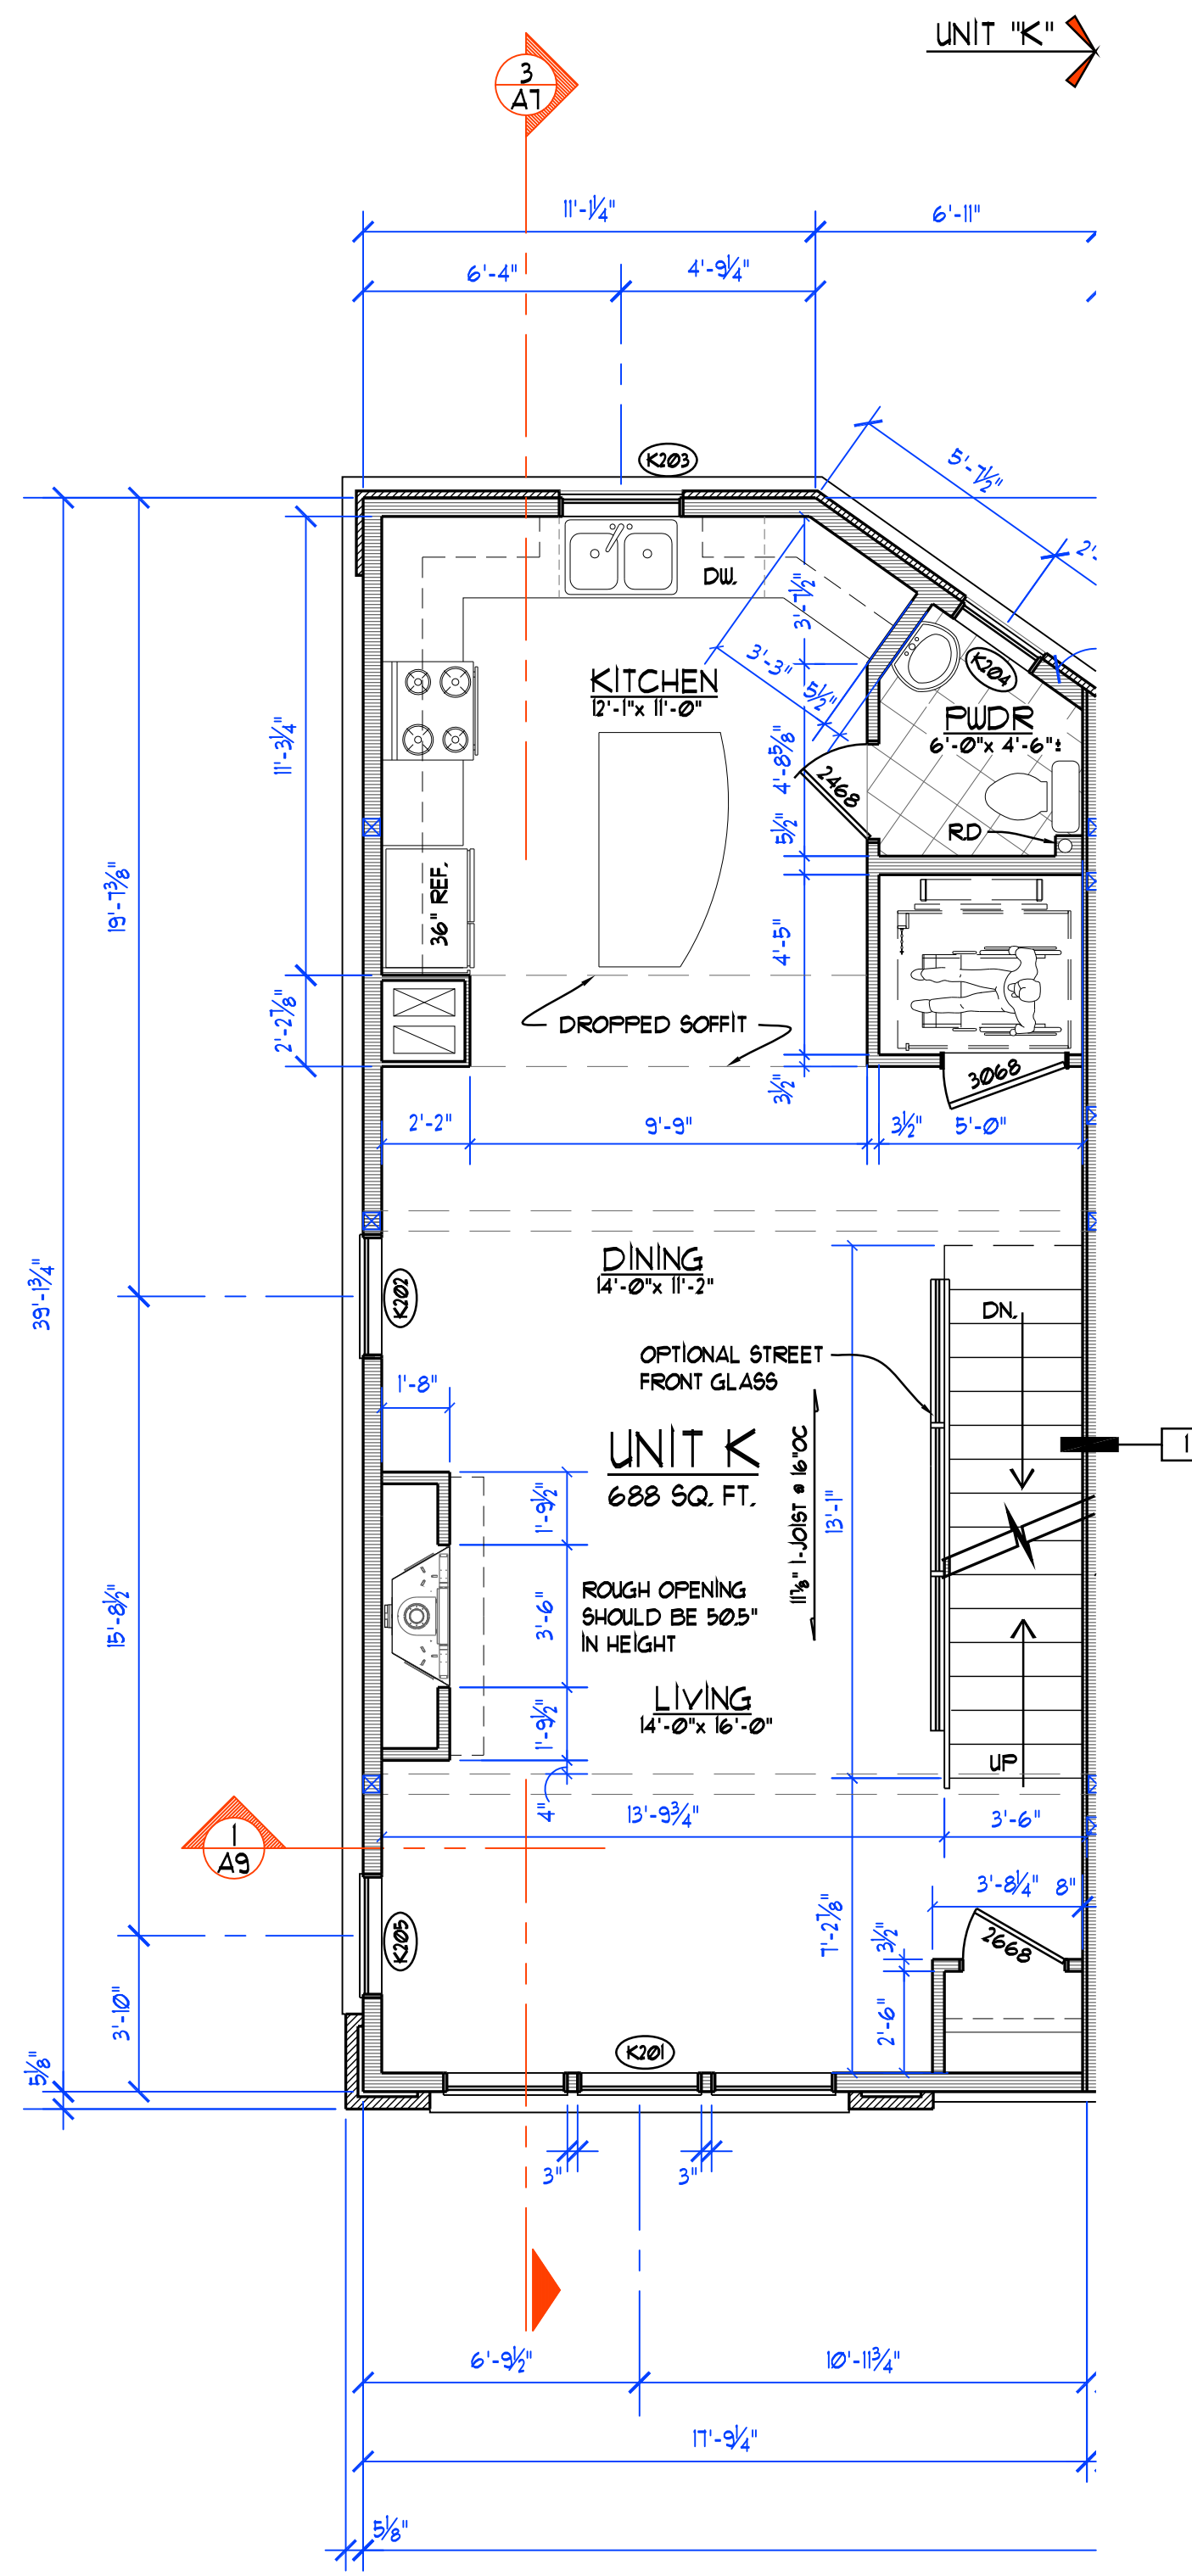

SECOND LEVEL FLOOR PLAN
 SCALE 1/4" = 1'-0"
 NORTH

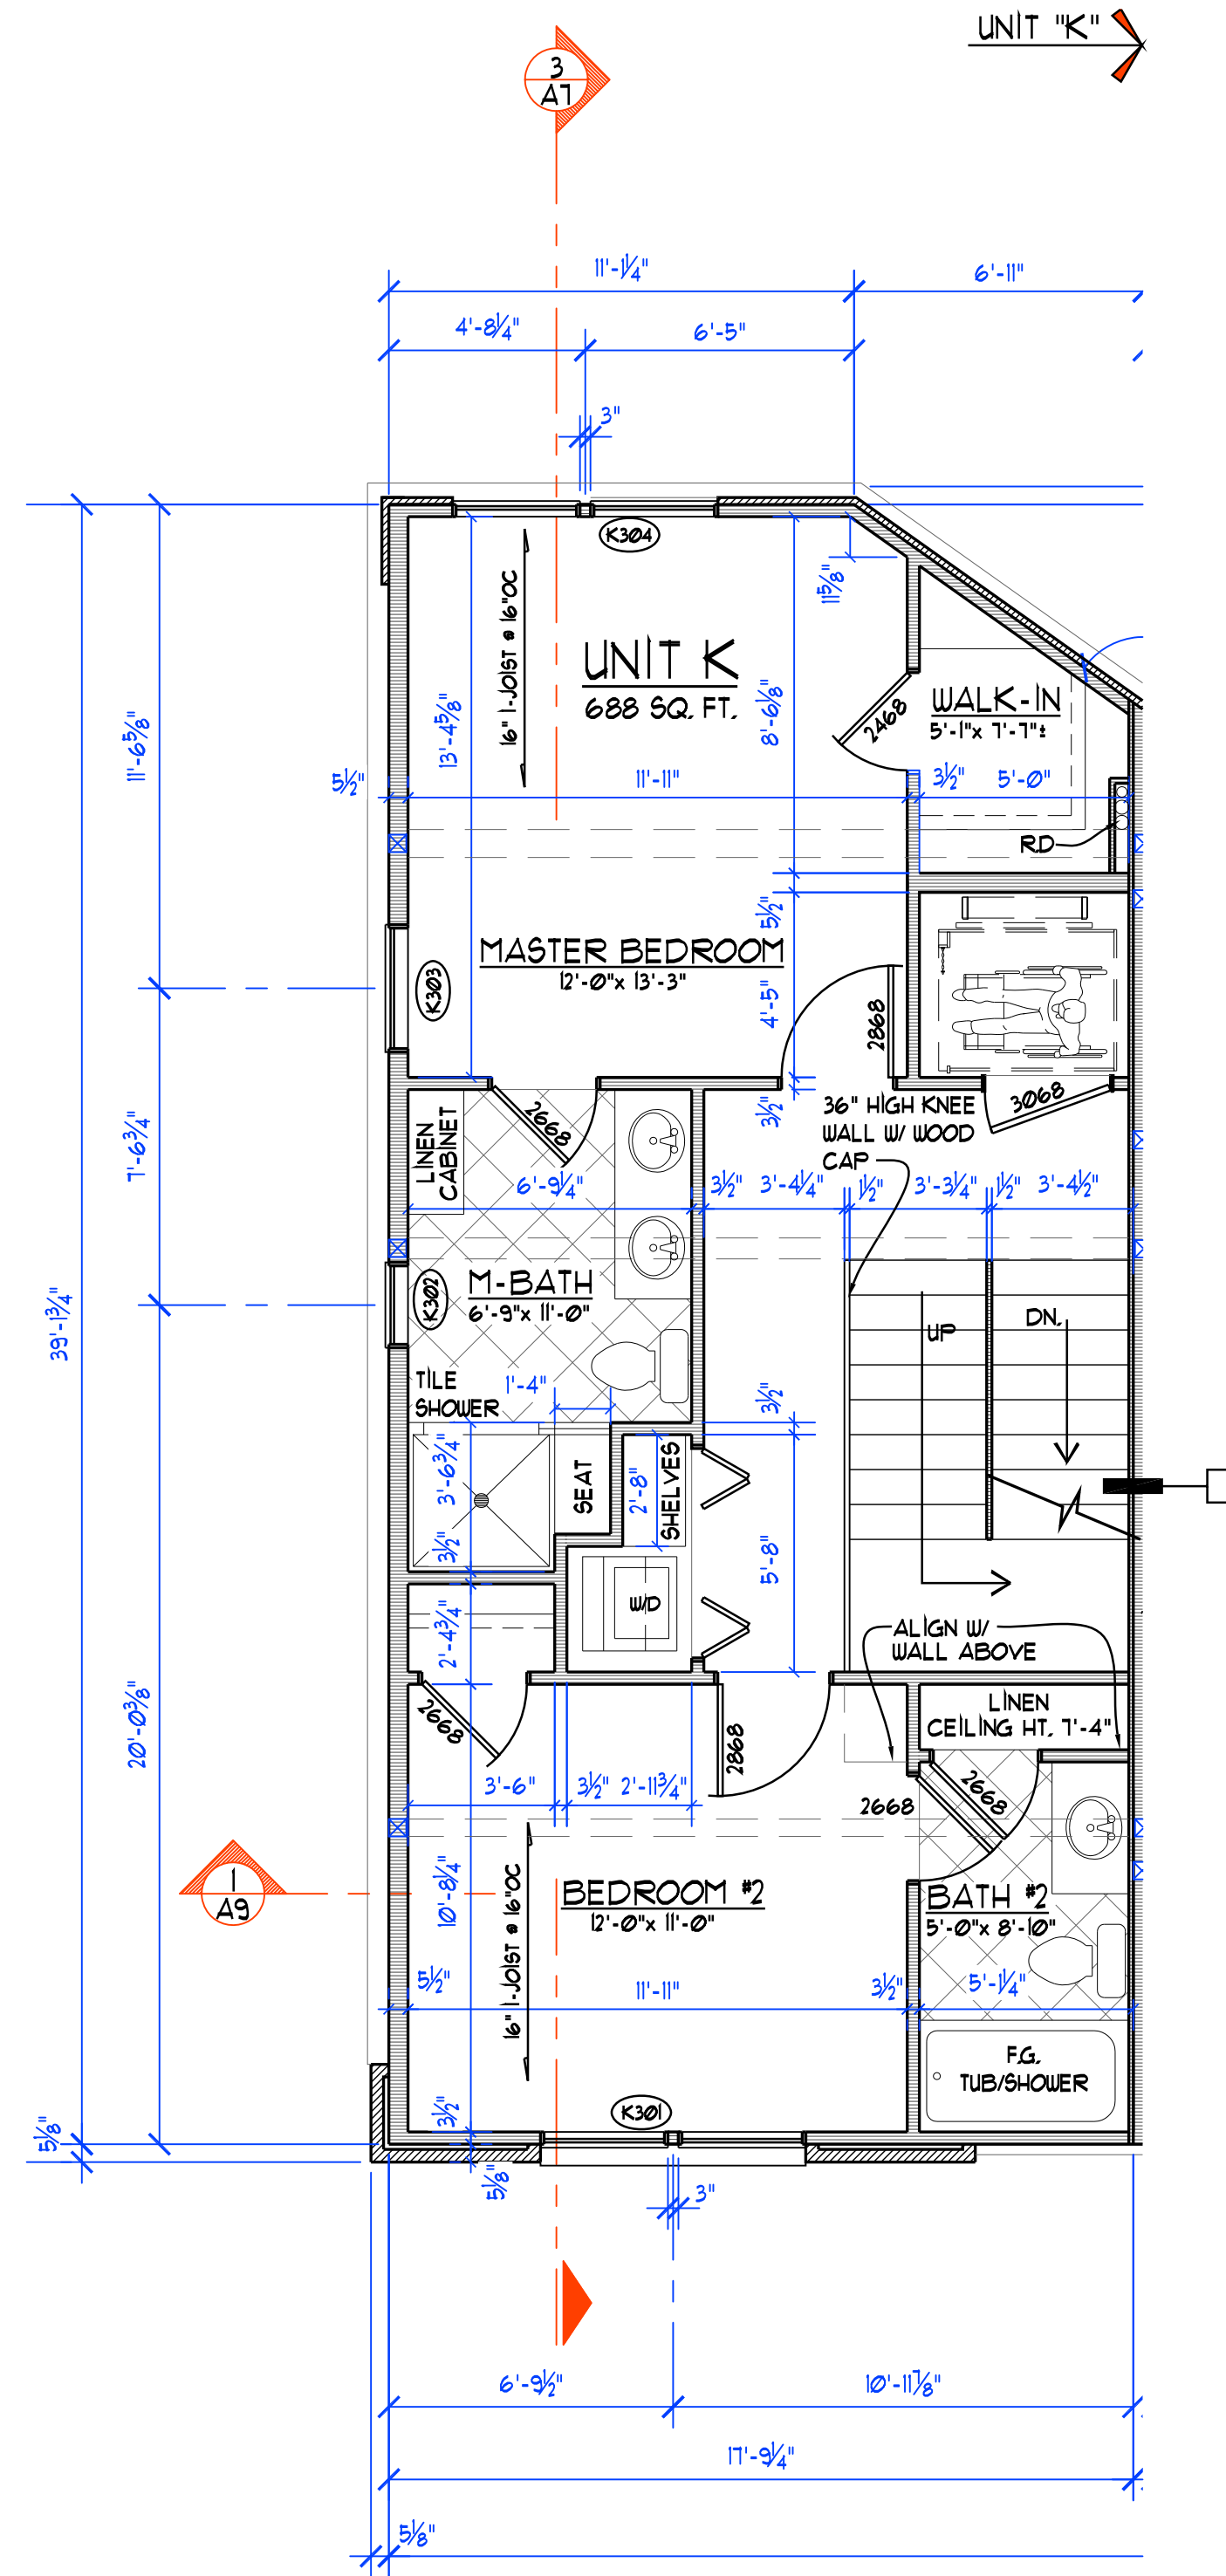

THIRD LEVEL FLOOR PLAN
 SCALE 1/4" = 1'-0"
 NORTH

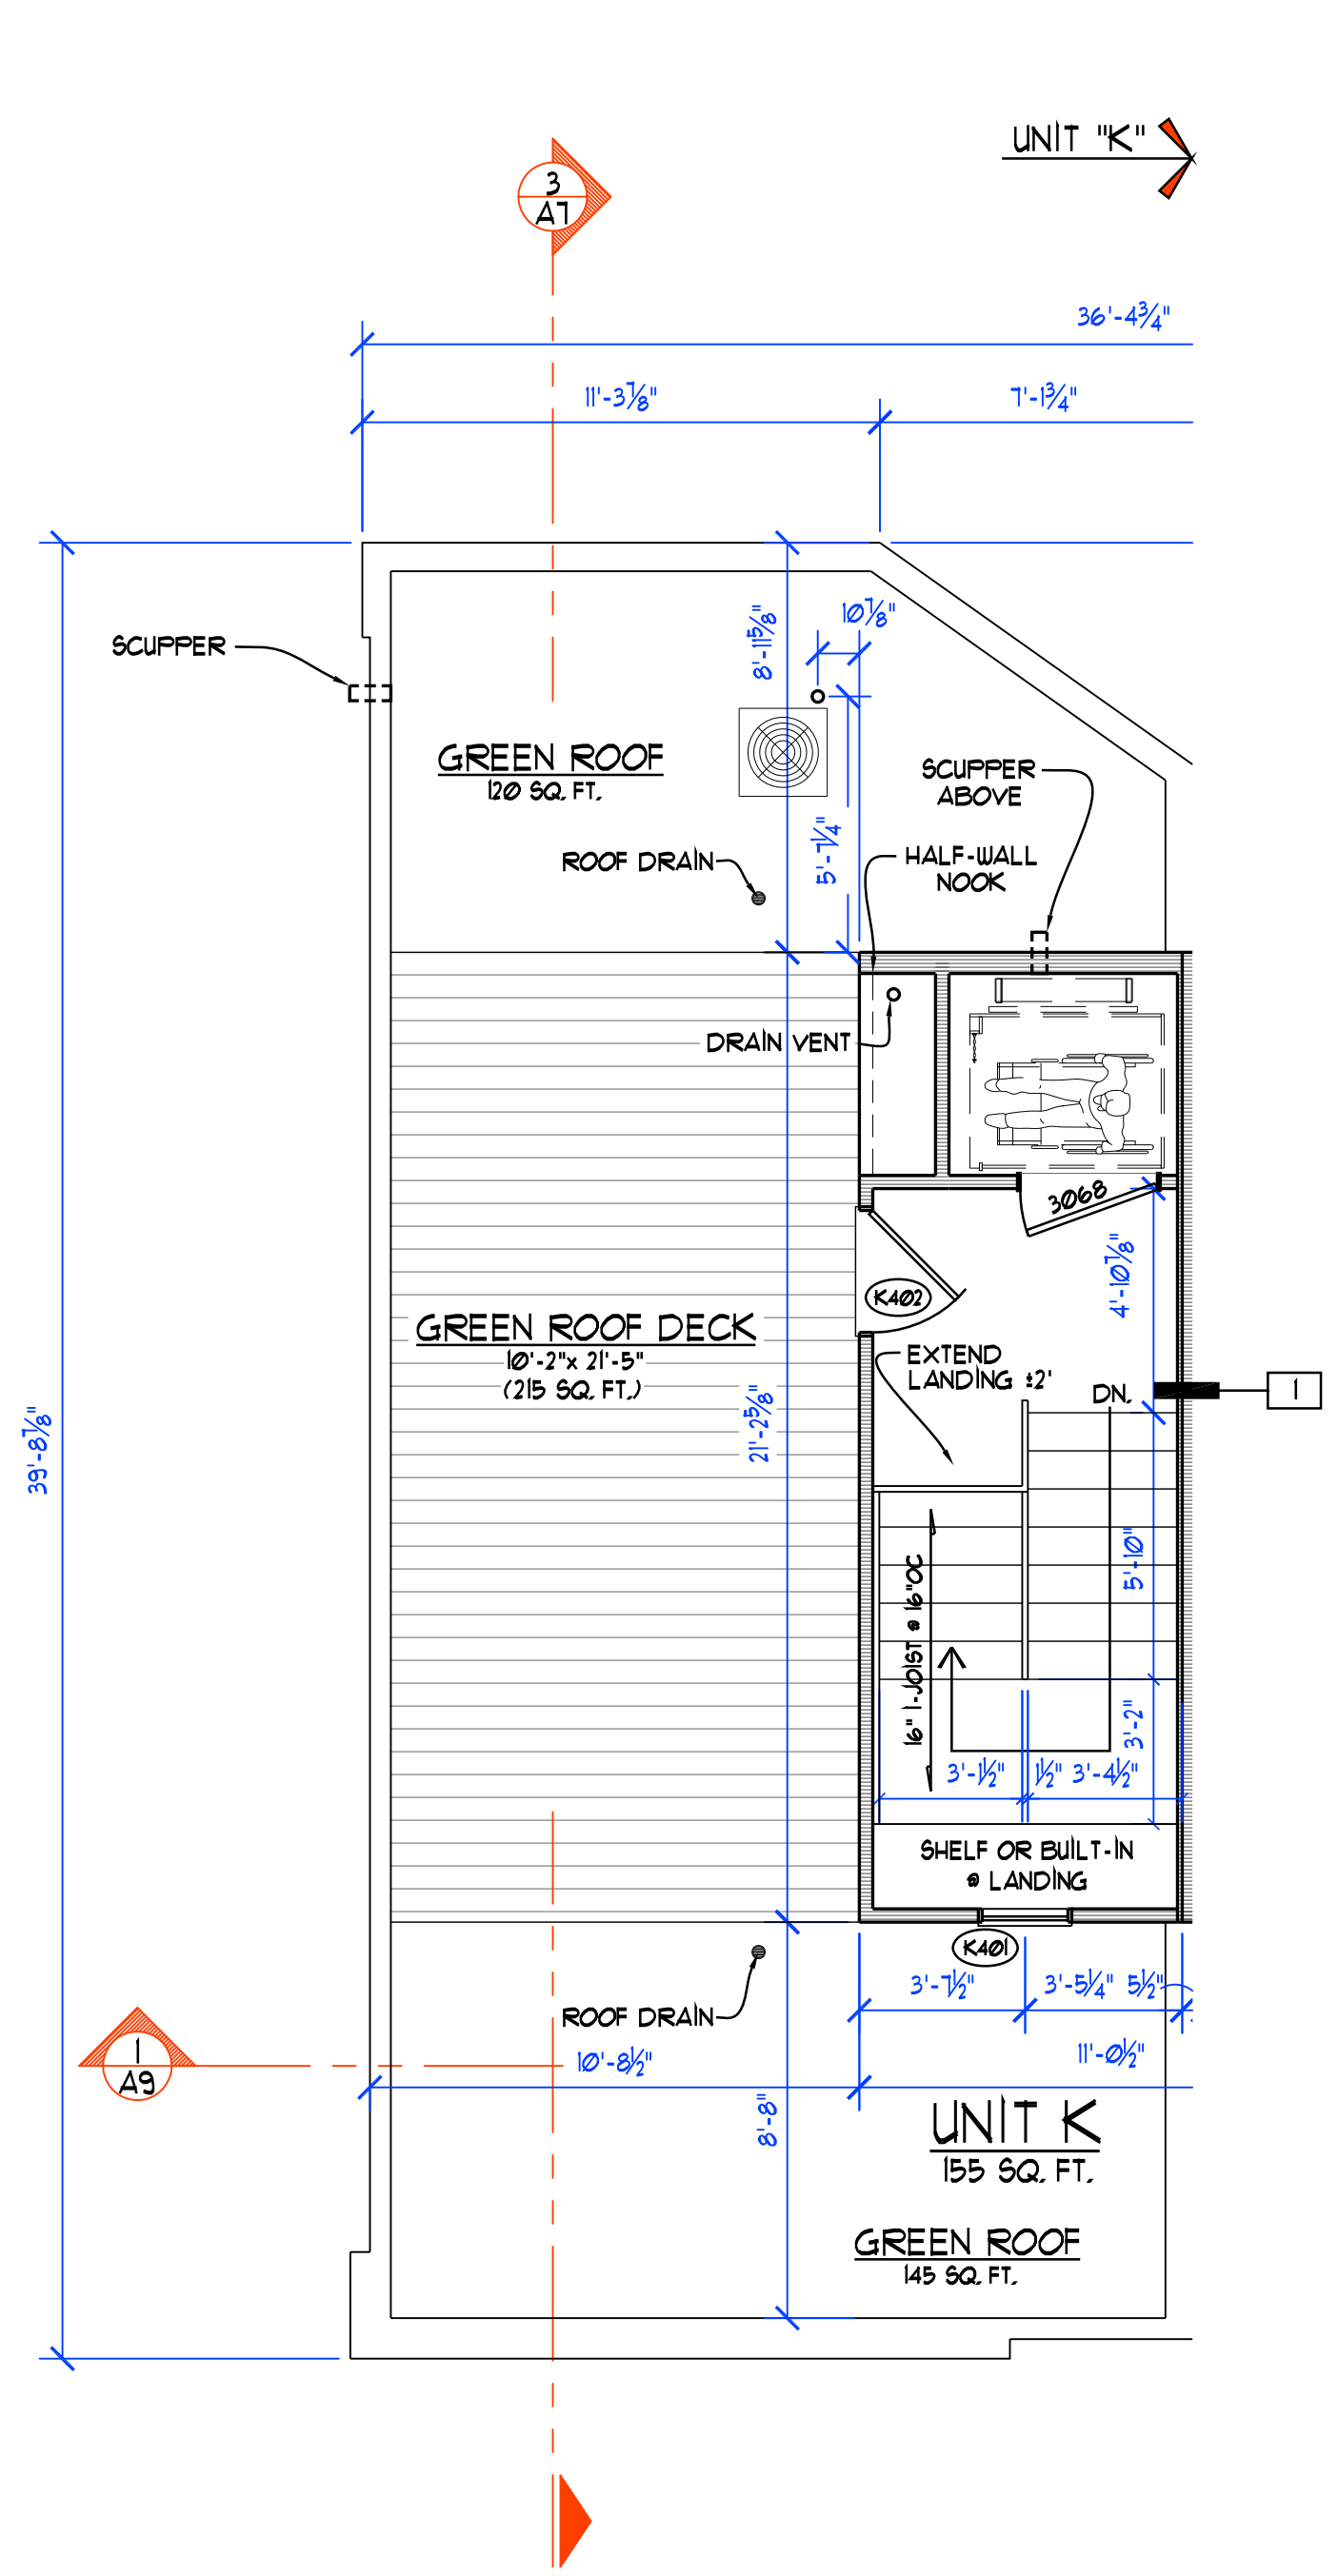

ROOF LEVEL FLOOR PLAN
 SCALE 1/4" = 1'-0"
 NORTH



WHITEFORD ASSOCIATES INC.

ARCHITECTURE
 CONSTRUCTION

328 MUNSON AVENUE
 SUITE B
 TRAVERSE CITY, MI 49686
 PH: (231) 941-8800
 FX: (231) 947-9099

UNIT K - FLOOR PLAN
 CITYSIDE - UPTOWN DEVELOPMENT
 131, 133, 135, 137, 139 W. STATE ST.
 TRAVERSE CITY, MICHIGAN

PROJECT #

DATE
 10-01-2015

REVISIONS
 10-08-2015 - 12-08-2015
 12-16-2015 - 01-26-2016
 02-04-2016 - 04-05-2016
 04-07-2016 - 12-19-2017

SHEET NUMBER

K